


Floor Plan scale 1: 100




DRAWING TITLE:	
FLOOR PLAN	N


GENERAL FLOOR PLAN NOTES		
and on Escape routes	tted within 3.0m of sleeping areas , as indicated on the drawings.) HAVE HUSH & TEST FACILITIES	
not shown. Air Seals to have PEF All windows and doors shown otherwise FOUNDATION: Standard foundations subject to final soil rep WALL FRAMING: Designed to high wind Stud Height: Exterior Walls: 90x44 Interior Loadbearing V mm ctrs max. Dwangs Ext: 90x45 @ Non loadbearing wall mm ctrs max.	xort. 1 zone 2420 mm 5mm studs @ 600 mm ctrs max. Valls: 90x45mm studs @ 600	
manufacturer and sha Refer to the truss desi BUILDING WRAP:	e confirmed by the precut Il comply with NZS 3604: 2011.	
INTERNAL DOORS: Internal Height: 1980n INSULATION: External Walls: Ceiling: Walls: Ceiling: Bathroom: Correr Finish:	R2.6 wall batts. R3.6 ceiling batts. LININGS Standard 10mm GIB (unless required for bracing) Standard 13mm GIB 13mm GIB Aqualine (bathrooms) 10mm GIB Aqualine Square	
INTERIOR AND EXTI Joinery: Interior: WATER HEATING Electric Hot water syst KITCHEN COOKTOP Electric.	Double Glazed Vantage Standard Aluminium Joinery Shelf and rail to wardrobes lem.	

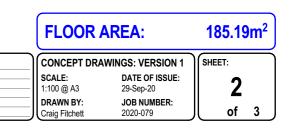

BEFORE CONSTRUCTION BEGINS, BUILDER MUST CHECK ALL DIMENSIONS ARE CORRECT AND ALL CONSTRUCTION WORK COMPLIES WITH THE NEW ZEALAND BUILDING CODE, LOCAL BODY BYLAWS AND RELEVANT NEW ZEALAND STANDARDS

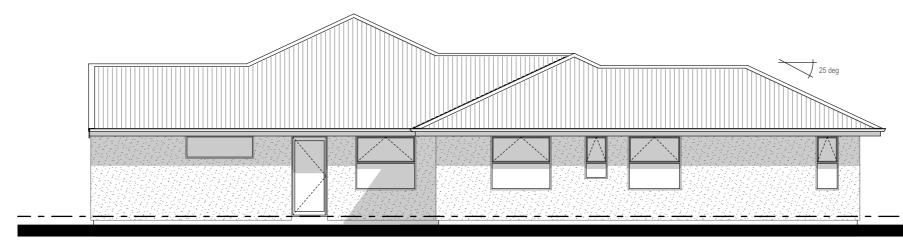



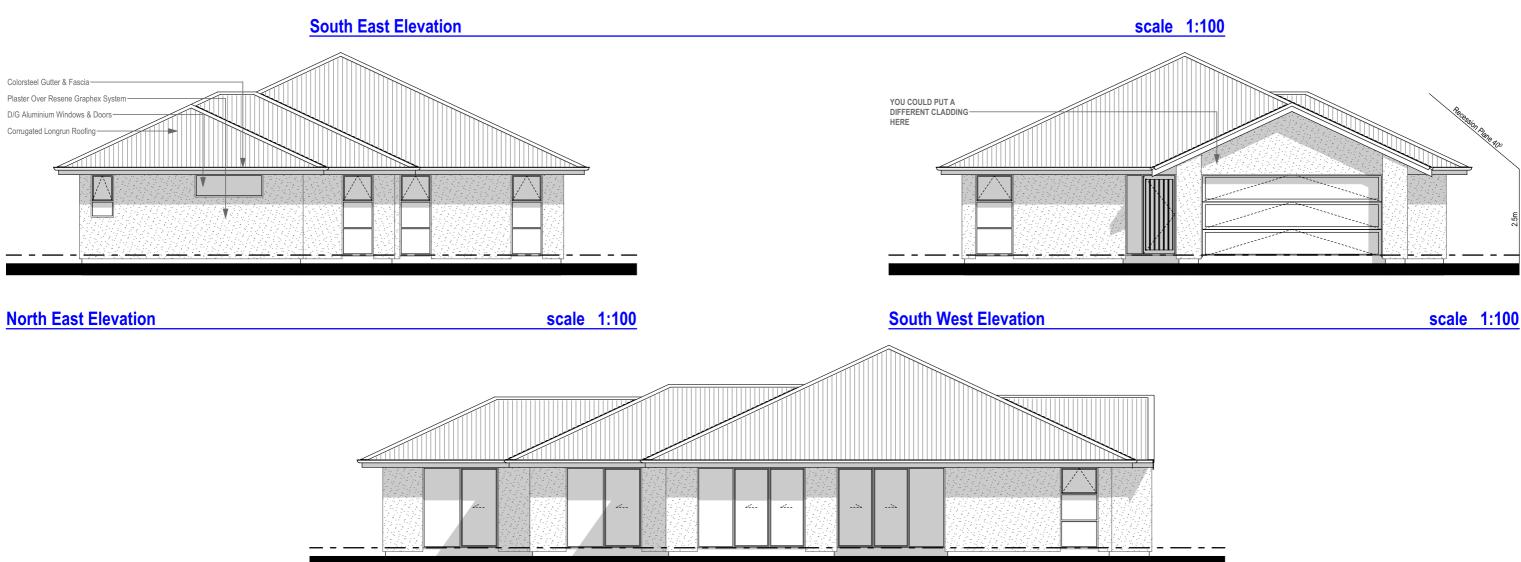

North West Elevation



DRAWING TITLE:		
E	LEVATIONS	

scale 1:100

